
9433 SE 54TH ST SITE PLAN

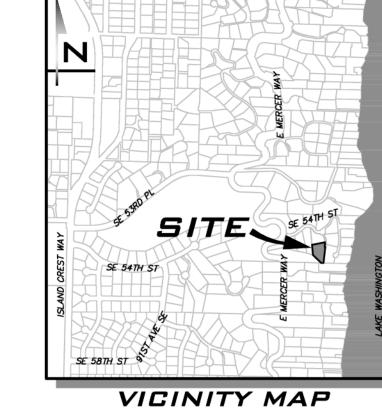

NOT TO SCALE

LEGEND

PROPOSED FEATURES

EXISTING FEATURES

-BOUNDARY

- LOT LINE

— SIDEWALK

— — — — — BUILDING OVERHANG

— — — — — — BUILDING SETBACK (BSBL)

———190——— 10' PROPOSED CONTOURS

---- ROOF & FOOTING DRAIN

SEWER SERVICE

→ ··· **→** ··· SWALE OR DITCH

→ SURFACE FLOW

—————— WATER MAIN

----- CENTERLINE ----- EASEMENT

— — —190— — — 10' CONTOURS

-----192----- 2' CONTOURS

— — — SS— *SEWER MAIN*

— — — W — WATER MAIN

— — — □ — BOARD FENCE RETAINING WALL

— — — G— *GAS MAIN*

COOCCOOCC ROCKERY

CLEARED AREA

— — — SD— *Storm Drain Pipe*

————OHP— AERIAL POWER LINE

☐ CATCH BASIN, TYPE I CATCH BASIN, TYPE II

SD PIPE FLOW

SS PIPE FLOW

A FIRE HYDRANT **₩ATER METER**

⋈ *GATE VALVE* -O- POWER POLE

← GUY ANCHOR

SEWER MANHOLE

— — — — — — SURFACE FEATURES '_//_/_BUILDING FOOTPRINT

—**192**——— 2' PROPOSED CONTOURS

----- SAWCUT

- CENTER LINE

∠∠BUILDING FOOTPRINT

- BUILDING ROOFLINE

STORM DRAIN PIPE

- ADJACENT PLAT/PARCEL LINE

— ADJACENT RIGHT-OF-WAY

RIGHT-OF-WAY

MAILBOX

CONCRETE

ASPHALT PAVEMENT

ATWELL

KIRKLAND, WA 98033 P: 425.216.4051 F: 425.216.4052

WWW.ATWELL-GROUP.COM

PROJECT MANAGER:

PROJECT ENGINEER: YANNICK METS, PE

TODD A OBERG, PE

SCALE:

AS NOTED

DESIGNER:

7/20/2023

JULIAN ADLER ISSUE DATE:

DRIVEWAY PROPOSED STORM DRAINAGE ■ TYPE I CB — STANDARD GRATE ■ TYPE I CB — LOCKING LID STORM CLEANOUT YARD DRAIN PROPOSED SANITARY SEWER AND WATER SEWER MANHOLE ◆ PIPE FLOW SEWER CLEANOUT ■ WATER METER P POWER VAULT **∕**S POWER METER \Box MAIL BOX

DECIDUOUS TREE EXISTING CONIFEROUS TREE

EXISTING DECIDUO
TO BE REMOVED EXISTING DECIDUOUS TREE

EXISTING CONIFEROUS TREE

EXISTING DECIDUOUS TREE

→ DRIP LINE

CONIFEROUS TREE

TO BE SAVED

TO BE SAVED

TO BE REMOVED

* | ASPHALT CONCRETE

GRAVEL TESC FEATURES FILTER FENCE ----- CONSTRUCTION FENCE

EXISTING UTILITIES ARE SHOWN IN THE APPROXIMATE LOCATION. THERE IS NO

GUARANTEE THAT ALL UTILITY LINES ARE SHOWN, OR THAT THE LOCATION, SIZE AND MATERIAL IS ACCURATE. THE CONTRACTOR SHALL UNCOVER ALL INDICATED

PIPING WHERE CROSSING, INTERFERENCES, OR CONNECTIONS OCCUR PRIOR TO

ACTUAL LOCATIONS, SIZE AND MATERIAL. THE CONTRACTOR SHALL MAKE THE

CONTRACTOR SHALL NOTIFY ONE CALL AT 8-1-1 (WASHINGTON811.COM) AND

ARRANGE FOR FIELD LOCATION OF EXISTING FACILITIES BEFORE CONSTRUCTION.

TRENCHING OR EXCAVATION FOR ANY PIPE OR STRUCTURES, TO DETERMINE

APPROPRIATE PROVISION FOR PROTECTION OF SAID FACILITIES. THE

LIMITS OF CLEARING

✓ PIPE FLOW INTERIM CATCH BASIN PROTECTION (INSERT)

EXISTING UTILITY NOTE

JOB NUMBER: *22-306* SHEET NAME:

07/20/2023

CV-01 _**]**__ of _ SHT

LEGAL DESCRIPTION

LOT 14, CAY HILLS, ACCORDING TO THE PLAT THEREOF, RECORDED IN VOLUME 70 OF PLATS, PAGE 95, IN KING COUNTY, WASHINGTON;

ALSO THAT PORTION OF GOVERNMENT LOT 2, SECTION 19. TOWNSHIP 24 NORTH. RANGE 5 EAST, WILLAMETTE MERIDIAN, IN KING COUNTY, WASHINGTON, DESCRIBED AS FOLLOWS:

BEGINNING AT THE SOUTHEAST CORNER OF LOT 14, CAY HILLS, ACCORDING TO THE PLAT THEREOF, RECORDED IN VOLUME 70 OF PLATS, PAGE 95, IN KING COUNTY, WASHINGTON; THENCE SOUTH 7'00'00" WEST 59.38 FEET TO THE SOUTHWEST CORNER OF LOT 10 OF THENCE NORTHWESTERLY TO THE SOUTHWEST CORNER OF SAID LOT 14;

THENCE ALONG THE SOUTHERLY LINES OF SAID LOT 14, SOUTH 71 30'00" EAST 80.00 FEET AND NORTH 86'30'00" EAST 42.00 FEET TO THE POINT OF BEGINNING.

VERTICAL DATUM & CONTROL INTERVAL

CONTOUR INTERVAL = 1 FT.

VERTICAL DATUM = NAVD'88, AS PER DIRECT OBSERVATIONS USING GPS EQUIPMENT ON MARCH 11, 2021.

HORIZONTAL DATUM = NAD 83/11

SURVEY NOTES

- 1. THIS SURVEY WAS PERFORMED BY FIELD TRAVERSE USING A 10 SECOND "TOTAL STATION" THEODOLITE SUPPLEMENTED WITH A 100 FT. STEEL TAPE. THIS SURVEY MEETS OR EXCEEDS THE STANDARDS FOR LAND BOUNDARY SURVEYS AS SET FORTH IN WAC CHAPTER 332-130-090.
- 2. THIS SURVEY WAS PERFORMED WITHOUT THE BENEFIT OF A CURRENT TITLE REPORT. THEREFORE EASEMENTS AFFECTING THE PROPERTY, IF ANY, ARE NOT
- 3. UNDERGROUND UTILITY INFORMATION AS SHOWN HEREON IS APPROXIMATE ONLY AND IS BASED UPON CITY OF SEATTLE GIS AND ALSO AS PER TIES TO ABOVE
- 4. TAX PARCEL NO. 1438700145
- 5. TREE DIAMETERS AND DRIPLINES DISPLAYED HEREON ARE APPROXIMATE. FOR SPECIFIC GENUS AND DIAMETER, TREES SHOULD BE EVALUATED BY A CERTIFIED
- 6. PARCEL AREA = 21666 SQ. FT.

SITE DATA

HIGHEST ELEVATION OF LOT: LOWEST ELEVATION OF LOT: LOT SLOPE: TOTAL SITE AREA: 21,666 SF 35% ALLOWED LOT COVERAGE:

4,484 SF (20.7%) PROPOSED LOT COVERAGE * PROPOSED HARDSCAPE 276 SF (1.3%) PROJECT IMPERVIOUS AREA: 4,760 SF (22.0%)

* LOT COVERAGE INCLUDES THE COMBINATION OF BUILDINGS, INCLUDING EAVES AND ROOF OVERHANGS, AND VEHICULAR DRIVING SURFACES AS DEFINED PER MIMC 19.16.010

OWNER / ARCHITECT

5425 96TH AVE SE MERCER ISLAND, WA 98040

(425) 922-5926 CONTACT: MEI YANG

ENGINEER

SURVEYOR CHADWICK & WINTERS

1422 N.W. 85TH ST. SEATTLE, WA 98117 (206) 297-0996 CONTACT: BRANDON E. WINTERS

GEOTECH ENGINEER

THE BLUELINE GROUP 25 CENTRAL WAY, SUITE 400 KIRKLAND, WA 98033 (425) 250-7262 CONTACT: YANNICK METS, PE

MERIT ENGINEERING, INC. 10129 MAIN STREET, #201 BELLEVUE, WA 98004 (425) 454-2133 CONTACT: AUSTIN X . HUANG

N 79°28′11" E 138.54 L=32.07' PROPOSED S 06'59'25" W 18.00' SINGLE FAMILY BSBL RESIDENCE S 83°00'35" E UFE-94.00 MFE 84.00 GFÉ 74.00 -60' STREAM BUFFER N 05"11'22" W 108.33' 10' BSBL -عددالما لاالمالالاللاللاللا BUILDING S 06'59'25" W 165.38' - EDGE OF CREEK N 46°51'24" W

SHEET INDEX

- CV-01 COVER SHEET
- 2 TP-01 TESC, DRAINAGE & TREE RETENTION PLAN
- 3 TP-02 TESC NOTES & DETAILS
- 4 SP-01 SITE PLAN
- 5 DT-01 DETAILS

BUILDING CALCULATIONS

SEE ARCHITECTURAL SITE PLAN FOR TREE RETENTION, BUILDING HEIGHTS AND FAR CALCULATIONS.

Ш

EDGE OF ASPHALT FALLS 4.5 FT WEST OF DEED

LINE AT THIS LOCATION

TELEPHONE PEDESTAL BOX

END OF ROCKERY
FALLS 6.3 FT SOUTH

OF DEED LINE

DECK

PORTION OF EX CONC (TO BE REMOVED)

WITH NEIGHBOR

WORK WITHIN TREE DRIPLINE
AREA TO BE PERFORMED UNDER

SUPERVISION OF ARBORIST (TYP)

N 0511'22" W 108.33'

APPLICANT TO COORDINATE

N 79°28′11" E


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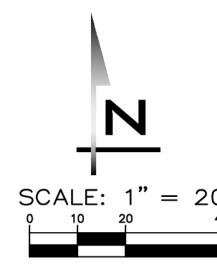
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(TO BE REMOVED)

#OSTØ 0 #OST

N 46°51'24" W 118.65'





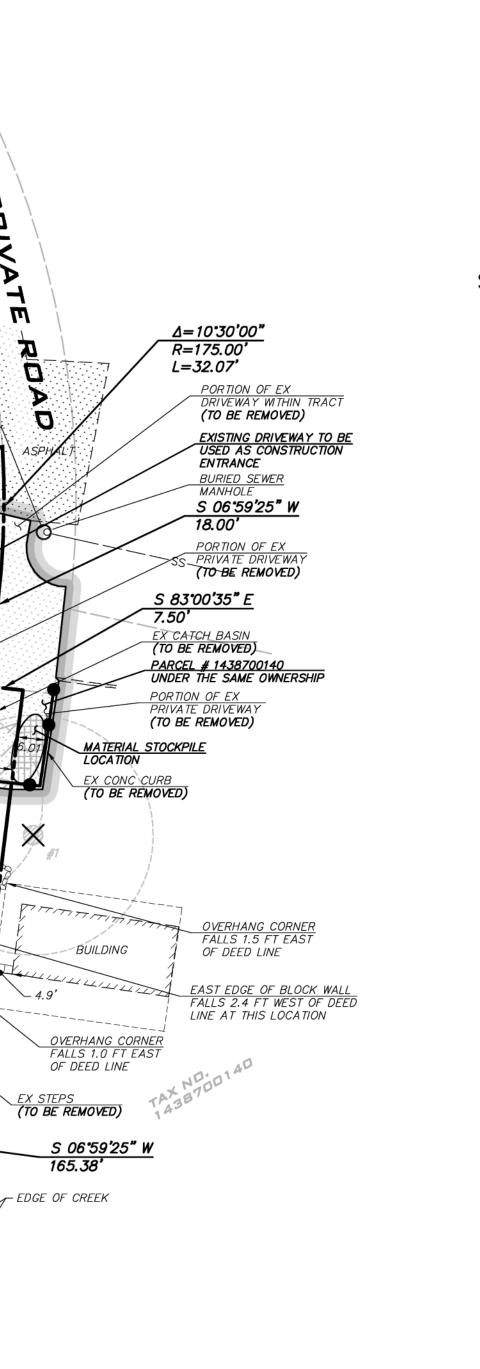

25 CENTRAL WAY, SUITE 400, KIRKLAND, WA 98033 P: 425.216.4051 F: 425.216.4052 WWW.ATWELL-GROUP.COM

SCALE: AS NOTED

PROJECT MANAGER: TODD A OBERG, PE

PROJECT ENGINEER: YANNICK METS, PE

DESIGNER: JULIAN ADLER ISSUE DATE: 7/20/2023

1. No pruning shall be performed unless under the

2. No equipment shall be stored or operated inside

the protective fencing including during fence

3. No storage of materials shall occur inside the

protective fencing. 4. Refer to Site/Utility Plan for any modifications t

5. Unauthorized activities in tree protection area

may require evaluation by private arborist to 6. Exposed Roots: For roots >1" damaged during construction, make a clean straight cut to remove damaged portion and inform city arborist.

2"x 6' steel posts

5" thick layer of mulch.

Maintain existing grade with the tree

direction of an arborist.

installation and removal.

the Tree Protection Area.

TREE PROTECTION FENCING NOT TO SCALE

SOIL AMENDMENT LEGEND

Crown drip line or other limit of Tree Protection area. See Site/Utility Plan for fence alignment.

A NEW TURF AREA REQUIRING AMENDMENT (1,715 SF)

POST-CONSTRUCTION SOIL MANAGEMENT NOTES

AMEND SOILS WITH COMPOST PER PRE-APPROVED AMENDMENT METHOD


SCARIFY EXISTING SOILS TO DEPTH OF 8 INCHES

sign laminated in plastic spaced every 50' along the fence.

REFER TO CITY OF MERCER ISLAND SECTION D: POST—CONSTRUCTION SOIL MANAGEMENT FORM UNDER SEPARATE COVER FOR CALCULATED AMENDMENT QUANTITIES.

EXISTING UTILITY NOTE

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07/20/2023

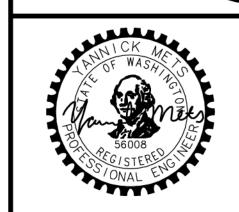
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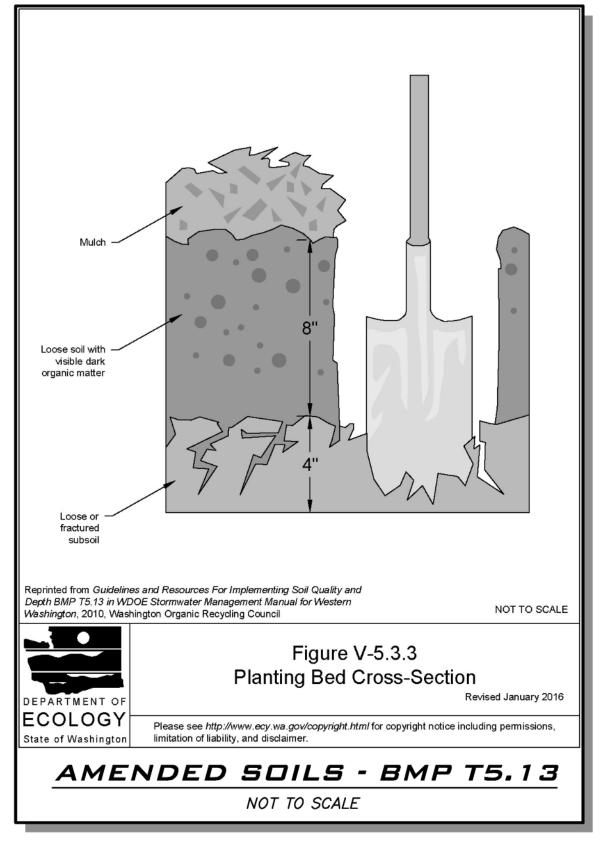
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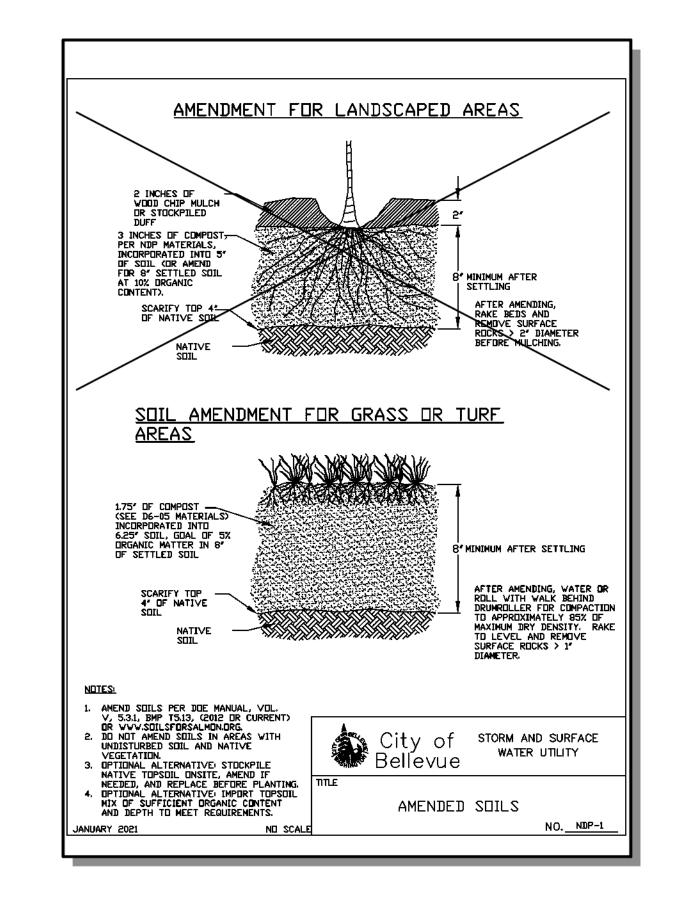
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TESC - PLAN NOTES

- 1. THE APPROVED CONSTRUCTION SEQUENCE SHALL BE AS FOLLOWS:
- A. CONDUCT PRE-CONSTRUCTION MEETING. B. FLAG OR FENCE CLEARING LIMITS.
- C. POST SIGN WITH NAME AND PHONE NUMBER OF TESC SUPERVISOR.
- D. INSTALL CATCH BASIN PROTECTION IF REQUIRED.
- E. GRADE AND INSTALL CONSTRUCTION ENTRANCE(S).
- F. INSTALL PERIMETER PROTECTION (SILT FENCE, BRUSH BARRIER, ETC.).
- G. CONSTRUCT SEDIMENT PONDS AND TRAPS.
- H. GRADE AND STABILIZE CONSTRUCTION ROADS.
- I. CONSTRUCT SURFACE WATER CONTROLS (INTERCEPTOR DIKES, PIPE SLOPE DRAINS, ETC.) SIMULTANEOUSLY WITH CLEARING AND GRADING FOR PROJECT DEVELOPMENT. J. MAINTAIN EROSION CONTROL MEASURE IN ACCORDANCE WITH CITY OF MERCER ISLAND
- STANDARDS AND MANUFACTURER'S RECOMMENDATIONS. K. RELOCATE EROSION CONTROL MEASURES OR INSTALL NEW MEASURES SO THAT AS SITE
- CONDITIONS CHANGE, THE EROSION AND SEDIMENT CONTROL IS ALWAYS IN ACCORDANCE WITH THE CITY TESC MINIMUM REQUIREMENTS. L. COVER ALL AREAS WITHIN THE SPECIFIED TIME FRAME WITH STRAW, WOOD FIBER MULCH,
- COMPOST, PLASTIC SHEETING, CRUSHED ROCK OR EQUIVALENT. M. STABILIZE ALL AREAS THAT REACH FINAL GRADE WITHIN 7 DAYS.
- N. SEED OR SOD ANY AREAS TO REMAIN UNWORKED FOR MORE THAN 30 DAYS. O. UPON COMPLETION OF THE PROJECT, ALL DISTURBED AREAS MUST BE STABILIZED AND
- BEST MANAGEMENT PRACTICES REMOVED IF APPROPRIATE. APPROVAL OF THIS EROSION/SEDIMENTATION CONTROL (ESC) PLAN DOES NOT CONSTITUTE AN APPROVAL OF PERMANENT ROAD OR DRAINAGE DESIGN (E.G., SIZE AND LOCATION OF ROADS, PIPES, RESTRICTORS, CHANNELS, RETENTION FACILITIES, UTILITIES, ETC.).
- 3. THE IMPLEMENTATION OF THIS ESC PLAN AND THE CONSTRUCTION, MAINTENANCE, REPLACEMENT, AND UPGRADING OF THESE ESC FACILITIES IS THE RESPONSIBILITY OF THE PERMITTEE/CONTRACTOR UNTIL ALL CONSTRUCTION IS APPROVED.
- 4. THE BOUNDARIES OF THE CLEARING LIMITS SHOWN ON THIS PLAN SHALL BE SET BY SURVEY AND CLEARLY FLAGGED IN THE FIELD BY A CLEARING CONTROL FENCE PRIOR TO CONSTRUCTION. DURING THE CONSTRUCTION PERIOD, NO DISTURBANCE OR REMOVAL OF ANY GROUND COVER BEYOND THE FLAGGED CLEARING LIMITS SHALL BE PERMITTED. THE FLAGGING SHALL BE MAINTAINED BY THE PERMITTEE/CONTRACTOR FOR THE DURATION OF CONSTRUCTION.
- THE TESC FACILITIES SHOWN ON THIS PLAN MUST BE CONSTRUCTED PRIOR TO OR IN CONJUNCTION WITH ALL CLEARING AND GRADING ACTIVITIES IN SUCH A MANNER AS TO ENSURE THAT SEDIMENT-LADEN WATER DOES NOT ENTER THE DRAINAGE SYSTEM OR VIOLATE APPLICABLE WATER STANDARDS. WHEREVER POSSIBLE. MAINTAIN NATURAL VEGETATION FOR SILT CONTROL.
- 6. THE ESC FACILITIES SHOWN ON THIS PLAN ARE THE MINIMUM REQUIREMENTS FOR ANTICIPATED SITE CONDITIONS. DURING THE CONSTRUCTION PERIOD, THESE ESC FACILITIES SHALL BE UPGRADED (E.G., ADDITIONAL SUMPS, RELOCATION OF DITCHES AND SILT FENCES, ETC.) AS NEEDED FOR UNEXPECTED STORM EVENTS. ADDITIONALLY, MORE TESC FACILITIES MAY BE REQUIRED TO ENSURE COMPLETE SILTATION CONTROL. THEREFORE, DURING THE COURSE OF CONSTRUCTION IT SHALL BE THE OBLIGATION AND RESPONSIBILITY OF THE CONTRACTOR TO ADDRESS ANY NEW CONDITIONS THAT MAY BE CREATED BY HIS ACTIVITIES AND TO PROVIDE ADDITIONAL FACILITIES OVER AND ABOVE THE MINIMUM REQUIREMENTS AS MAY BE NEEDED.
- 7. THE ESC FACILITIES SHALL BE INSPECTED BY THE PERMITTEE/CONTRACTOR DAILY DURING NON-RAINFALL PERIODS, EVERY HOUR (DAYLIGHT) DURING A RAINFALL EVENT, AND AT THE END OF EVERY RAINFALL, AND MAINTAINED AS NÉCESSARY TO ENSURE THEIR CONTINUED FUNCTIONING. IN ADDITION, TEMPORARY SILTATION PONDS AND ALL TEMPORARY SILTATION CONTROLS SHALL BE MAINTAINED IN A SATISFACTORY CONDITION UNTIL SUCH TIME THAT CLEARING AND OR CONSTRUCTION IS COMPLETED, PERMANENT DRAINAGE FACILITIES ARE OPERATIONAL, AND THE POTENTIAL FOR EROSION HAS PASSED. WRITTEN RECORDS SHALL BE KEPT DOCUMENTING THE REVIEWS OF THE ESC FACILITIES.
- 8. THE ESC FACILITIES ON INACTIVE SITES SHALL BE INSPECTED AND MAINTAINED A MINIMUM OF ONCE A MONTH OR WITHIN 48 HOURS FOLLOWING A STORM EVENT.
- 9. ALL DENUDED SOILS MUST BE STABILIZED WITH AN APPROVED TESC METHOD (E.G. SEEDING, MULCHING, PLASTIC COVERING, CRUSHED ROCK) WITHIN THE FOLLOWING TIMELINES: APRIL 1 TO OCTOBER 31 — SOILS MUST BE STABILIZED WITHIN 7 DAYS OF GRADING.
- NOVEMBER 1 TO MARCH 31 SOILS MUST BE STABILIZED WITHIN 2 DAYS OF GRADING. 10. AT NO TIME SHALL MORE THAN 1'OF SEDIMENT BE ALLOWED TO ACCUMULATE WITHIN A CATCH BASIN. ALL CATCH BASINS AND CONVEYANCE LINES SHALL BE CLEANED PRIOR TO PAVING. THE CLEANING OPERATION SHALL NOT FLUSH SEDIMENT-LADEN WATER INTO THE DOWNSTREAM SYSTEM.
- 11. STABILIZED CONSTRUCTION ENTRANCES SHALL BE INSTALLED AT THE BEGINNING OF CONSTRUCTION AND MAINTAINED FOR THE DURATION OF THE PROJECT. ADDITIONAL MEASURES, SUCH AS WASH PADS, MAY BE REQUIRED TO ENSURE THAT ALL PAVED AREAS
- ARE KEPT CLEAN FOR THE DURATION OF THE PROJECT. 12. ANY PERMANENT RETENTION/DETENTION FACILITY USED AS A TEMPORARY SETTLING BASIN SHALL BE MODIFIED WITH THE NECESSARY EROSION CONTROL MEASURES AND SHALL PROVIDE ADEQUATE STORAGE CAPACITY. IF THE PERMANENT FACILITY IS TO FUNCTION ULTIMATELY AS AN INFILTRATION OR DISPERSION SYSTEM, THE FACILITY SHALL NOT BE USED AS A TEMPORARY SETTLING BASIN. NO UNDERGROUND DETENTION TANK, DETENTION VAULT, OR SYSTEM WHICH BACKS UNDER OR INTO A POND SHALL BE USED AS A TEMPORARY SETTLING BASIN.
- WHERE SEEDING FOR TEMPORARY EROSION CONTROL IS REQUIRED, FAST GERMINATING GRASSES SHALL BE APPLIED AT AN APPROPRIATE RATE (EXAMPLE: ANNUAL OR PERENNIAL RYE APPLIED AT APPROXIMATELY 80 POUNDS PER ACRE).
- 14. WHERE STRAW MULCH IS REQUIRED FOR TEMPORARY ERÓSION CONTROL, IT SHALL BE APPLIED AT A MINIMUM THICKNESS OF 2".
- 15. ALL EROSION/SEDIMENTATION CONTROL PONDS WITH A DEAD STORAGE DEPTH EXCEEDING 6" MUST HAVE A PERIMETER FENCE WITH A MINIMUM HEIGHT OF 3'.
- 16. ALL WORK AND MATERIALS SHALL BE IN ACCORDANCE WITH CITY OF MERCER ISLAND STANDARDS AND SPECIFICATIONS.
- 17. THE ESC FACILITIES SHALL BE CONSTRUCTED IN ACCORDANCE WITH THE DETAILS ON THE APPROVED PLANS. LOCATIONS MAY BE MOVED TO SUIT FIELD CONDITIONS, SUBJECT TO
- APPROVAL BY THE ENGINEER AND THE CITY OF MERCER ISLAND INSPECTOR. 18. A COPY OF THE APPROVED EROSION CONTROL PLANS MUST BE ON THE JOB SITE WHENEVER
- CONSTRUCTION IS IN PROGRESS. 19. ALL LOTS ADJOINING OR HAVING ANY NATIVE GROWTH PROTECTION EASEMENTS (NGPE) SHALL HAVE A 4' HIGH TEMPORARY CONSTRUCTION FENCE (CYCLONE OR PLASTIC MESH) SEPARATING THE LOT (OR BUILDABLE PORTIONS OF THE LOT) FROM THE AREA RESTRICTED BY THE NGPE AND SHALL BE INSTALLED PRIOR TO ANY GRADING OR CLEARING AND REMAIN IN PLACE UNTIL A DWELLING IS CONSTRUCTED AND OWNERSHIP TRANSFERRED TO THE FIRST
- OWNER/OCCUPANT. 20. CLEARÍNG LIMITS SHALL BE DELINEATED WITH A CLEARING CONTROL FENCE. THE CLEARING CONTROL FENCE SHALL CONSIST OF A 6-FT. HIGH CHAIN LINK FENCE ADJACENT THE DRIP LINE OF TREES TO BE SAVED, WETLAND OR STREAM BUFFERS, AND SENSITIVE SLOPES. CLEARING CONTROL FENCES ALONG WETLAND OR STREAM BUFFERS OR UPSLOPE OF SENSITIVE SLOPES SHALL BE ACCOMPANIED BY AN EROSION CONTROL FENCE. IF APPROVED BY THE CITY. A FOUR-FOOT HIGH ORANGE MESH CLEARING CONTROL FENCE MAY BE USED
- TO DELINEATE CLEARING LIMITS IN ALL OTHER AREAS. 21. OFF-SITE STREETS MUST BE KEPT CLEAN AT ALL TIMES. IF DIRT IS DEPOSITED ON THE PUBLIC STREET SYSTEM, THE STREET SHALL BE IMMEDIATELY CLEANED WITH POWER SWEEPER OR OTHER EQUIPMENT. ALL VEHICLES SHALL LEAVE THE SITE BY WAY OF THE CONSTRUCTION ENTRANCE AND SHALL BE CLEANED OF ALL DIRT THAT WOULD BE DEPOSITED
- ON THE PUBLIC STREETS. 22. ANY CATCH BASINS COLLECTING RUNOFF FROM THE SITE, WHETHER THEY ARE ON OR OFF THE SITE, SHALL HAVE THEIR GRATES COVERED WITH FILTER FABRIC DURING CONSTRUCTION. CATCH BASINS DIRECTLY DOWNSTREAM OF THE CONSTRUCTION ENTRANCE OR ANY OTHER CATCH BASIN AS DETERMINED BY THE CITY INSPECTOR SHALL BE PROTECTED WITH A "FILTER FABRIC SOCK" OR EQUIVALENT.
- 23. THE WASHED GRAVEL BACKFILL ADJACENT TO THE FILTER FABRIC FENCE SHALL BE REPLACED AND THE FILTER FABRIC CLEANED IF IT IS NONFUNCTIONAL BY EXCESSIVE SILT ACCUMULATION AS DETERMINED BY THE CITY OF MERCER ISLAND. ALSO, ALL INTERCEPTOR SWALES SHALL BE CLEANED IF SILT ACCUMULATION EXCEEDS ONE—QUARTER DEPTH.
- 24. ROCK FOR EROSION PROTECTION OF ROADWAY DITCHES, WHERE REQUIRED, MUST BE OF SOUND QUARRY ROCK, PLACED TO A DEPTH OF 1' AND MUST MEET THE FOLLOWING SPECIFICATIONS: 4"-8" ROCK/40 %-70 % PASSING; 2"-4" ROCK/30 %-40 % PASSING; AND 1"-2" ROCK/10 %-20 % PASSING.
- 25. IF ANY PART(S) OF THE CLEARING LIMIT BOUNDARY OR TEMPORARY EROSION/SEDIMENTATION CONTROL PLAN IS/ARE DAMAGED, IT SHALL BE REPAIRED IMMEDIATELY.
- 26. ALL PROPERTIES ADJACENT TO THE PROJECT SITE SHALL BE PROTECTED FROM SEDIMENT
- DEPOSITION AND RUNOFF. 27. DO NOT FLUSH CONCRETE BY-PRODUCTS OR TRUCKS NEAR OR INTO THE STORM DRAINAGE SYSTEM. IF EXPOSED AGGREGATE IS FLUSHED INTO THE STORM SYSTEM, IT COULD MEAN RE-CLEANING THE ENTIRE DOWNSTREAM STORM SYSTEM, OR POSSIBLY RE-LAYING THE
- STORM LINE. 28. PRIOR TO THE OCTOBER 1 OF EACH YEAR (THE BEGINNING OF THE WET SEASON), ALL DISTURBED AREAS SHALL BE REVIEWED TO IDENTIFY WHICH ONES CAN BE SEEDED IN PREPARATION FOR THE WINTER RAINS. THE IDENTIFIED DISTURBED AREA SHALL BE SEEDED WITHIN ONE WEEK AFTER OCTOBER 1. A SITE PLAN DEPICTING THE AREAS TO BE SEEDED AND THE AREAS TO REMAIN UNCOVERED SHALL BE SUBMITTED TO THE PUBLIC WORKS CONSTRUCTION INSPECTOR. THE INSPECTOR CAN REQUIRE SEEDING OF ADDITIONAL AREAS IN ORDER TO PROTECT SURFACE WATERS, ADJACENT PROPERTIES, OR DRAINAGE FACILITIES.







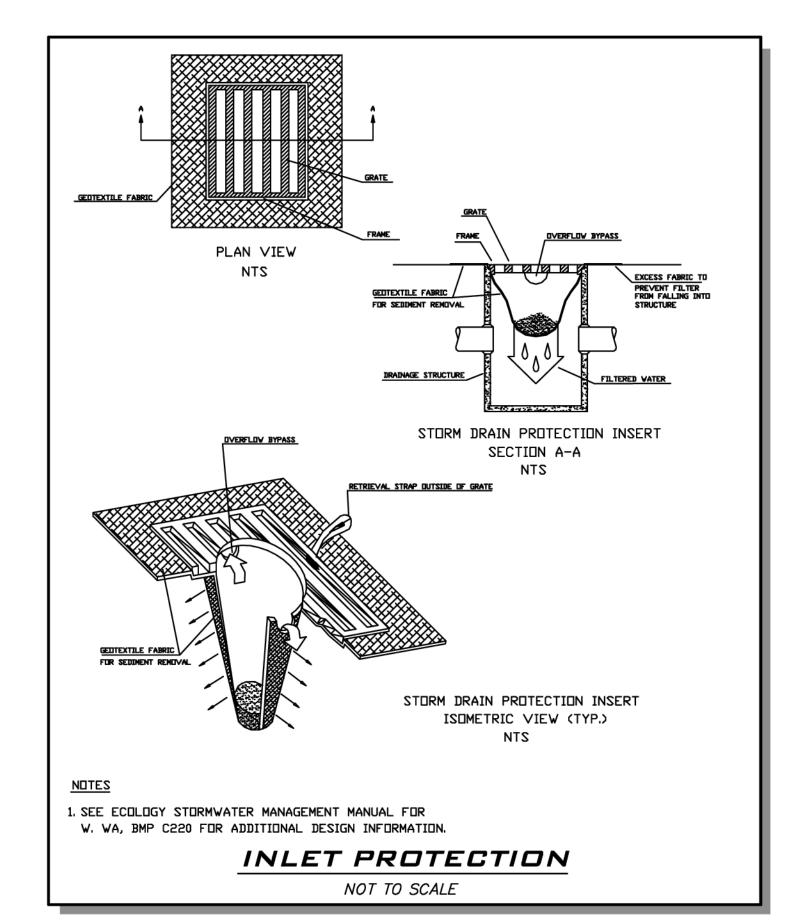


SCALE: AS NOTED PROJECT MANAGER: TODD A OBERG, PE PROJECT ENGINEER: YANNICK METS, PE DESIGNER: JULIAN ADLER ISSUE DATE: 7/20/2023

07/20/2023 JOB NUMBER:

SHEET NAME: TP-02

22-306

3 of SHT

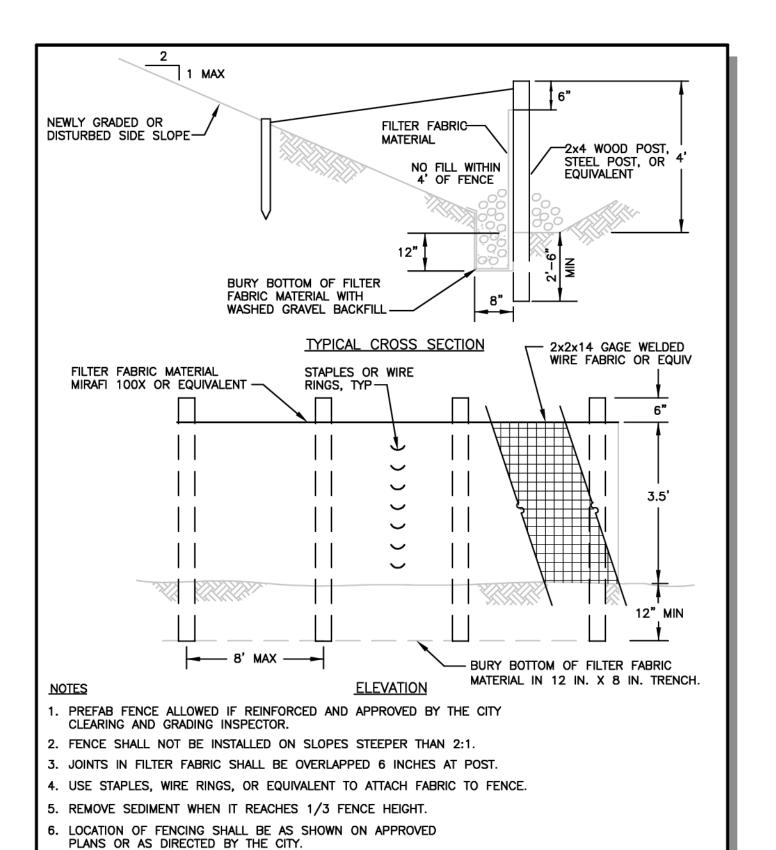



SILT FENCE

NOT TO SCALE

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ANCHOR ASSEMBLY CORRUGATED **METAL PIPE**

NOT TO SCALE

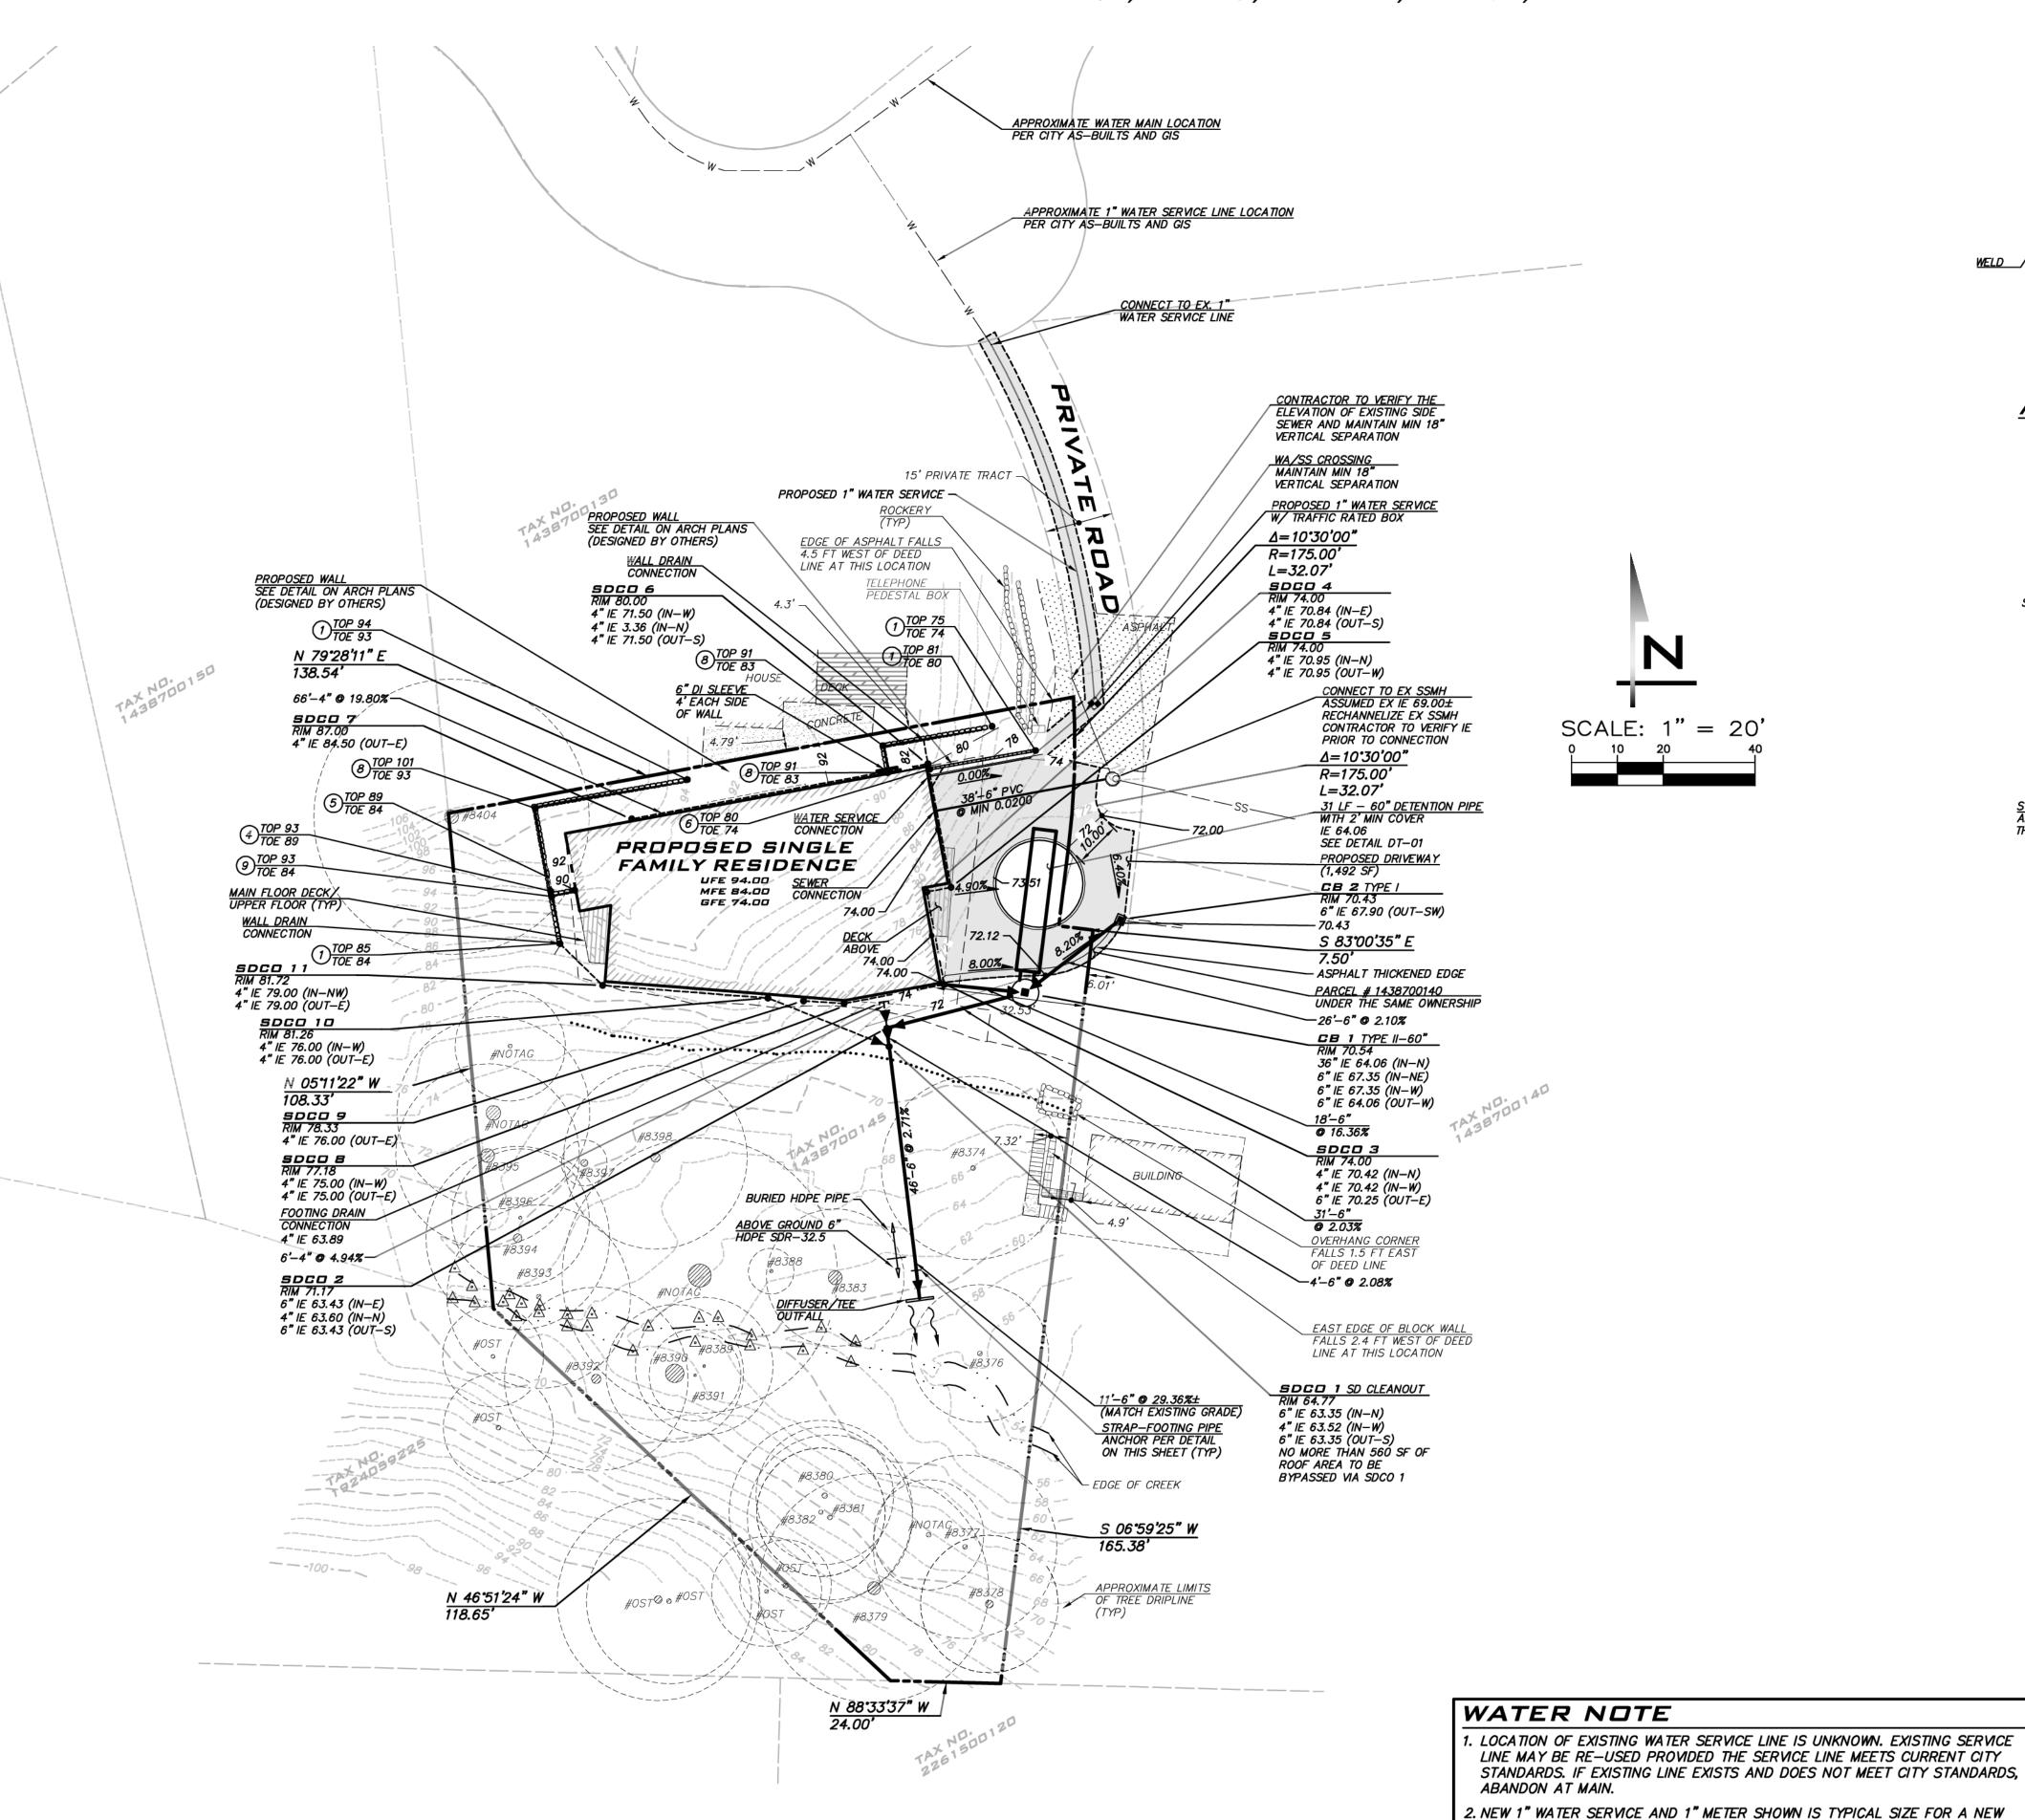FLATTEN TO

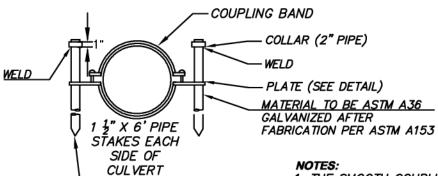
1. THE SMOOTH COUPLING BAND SHALL BE USED IN COMBINATION WITH CONCRETE PIPE. 2. CONCRETE PIPE WITHOUT BELL AND SPIGOT SHALL NOT BE INSTALLED ON GRADES IN EXCESS OF

3. THE FIRST ANCHOR SHALL BE INSTALLED ON THE FIRST SECTION OF THE LOWER END OF THE PIPE AND REMAINING ANCHORS EVENLY SPACED THROUGHOUT THE INSTALLATION.

4. IF THE PIPE BEING INSTALLED HAS A MANHOLE OR CATCH BASIN ON THE LOWER END OF THE PIPE, THE FIRST PIPE ANCHOR MAY BE FUNDATED.

- THE FIRST PIPE ANCHOR MAY BE ELIMINATED. 5. WHEN CMP IS USED, THE ANCHORS MAY BE ATTACHED TO THE COUPLING BANDS USED TO JOIN THE PIPE AS LOSEDED
- SPACING IS NOT EXCEEDED. 6. ALL PIPE ANCHORS SHALL BE SECURELY INSTALLED BEFORE BACKFILLING AROUND THE

SOURCE: 2021 KING COUNTY SURFACE WATER DESIGN MANUAL FIGURE 4.2.1-C

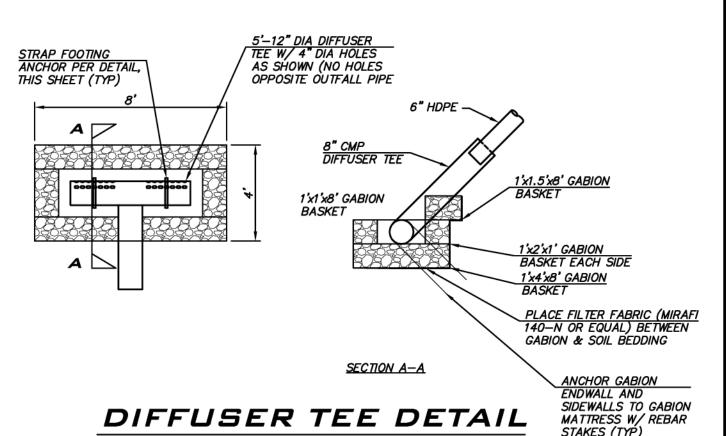

SCALE: 1"=4"

AMENDED SOILS

SINGLE FAMILY HOME WITH FIRE SPRINKLERS. SIZE MAY VARY, BASED ON UPC

SIZING CRITERIA, AND SHALL BE CONFIRMED BY BUILDER PRIOR TO

3. INSTALL WATER SERVICE PER MERCER ISLAND STD DTL W-13

CONSTRUCTION.

THE LAWN AND LANDSCAPE AREAS ARE REQUIRED TO PROVIDE POST-CONSTRUCTION SOIL QUALITY AND DEPTH IN ACCORDANCE WITH BMP T5.13. THE PROJECT CIVIL ENGINEER MUST PROVIDE A LETTER OF CERTIFICATION TO ENSURE THAT THE LAWN AND LANDSCAPE AREAS ARE MEETING THE POST-CONSTRUCTION SOIL QUALITY AND DEPTH REQUIREMENTS SPECIFIED ON THE APPROVED PLAN SET PRIOR TO FINAL INSPECTION OF THE PROJECT.

SANITARY SEWER NOTES

PROPOSED SEWER SERVICE LINE TO BE INSTALLED PER CITY OF MERCER ISLAND STANDARD DETAIL S-18.

EXISTING UTILITY NOTE

EXISTING UTILITIES ARE SHOWN IN THE APPROXIMATE LOCATION. THERE IS NO GUARANTEE THAT ALL UTILITY LINES ARE SHOWN, OR THAT THE LOCATION, SIZE AND MATERIAL IS ACCURATE. THE CONTRACTOR SHALL UNCOVER ALL INDICATED PIPING WHERE CROSSING, INTERFERENCES, OR CONNECTIONS OCCUR PRIOR TO TRENCHING OR EXCAVATION FOR ANY PIPE OR STRUCTURES, TO DETERMINE ACTUAL LOCATIONS, SIZE AND MATERIAL. THE CONTRACTOR SHALL MAKE THE APPROPRIATE PROVISION FOR PROTECTION OF SAID FACILITIES. THE CONTRACTOR SHALL NOTIFY ONE CALL AT 8-1-1 (WASHINGTON811.COM) AND ARRANGE FOR FIELD LOCATION OF EXISTING FACILITIES BEFORE CONSTRUCTION.



25 CENTRAL WAY, SUITE 400, KIRKLAND, WA 98033 P: 425.216.4051 F: 425.216.4052

WWW.ATWELL-GROUP.COM SCALE: AS NOTED

PROJECT MANAGER: TODD A OBERG, PE PROJECT ENGINEER:

YANNICK METS, PE

DESIGNER: JULIAN ADLER ISSUE DATE:

7/20/2023


07/20/2023

22-306 SHEET NAME: SP-01

JOB NUMBER:

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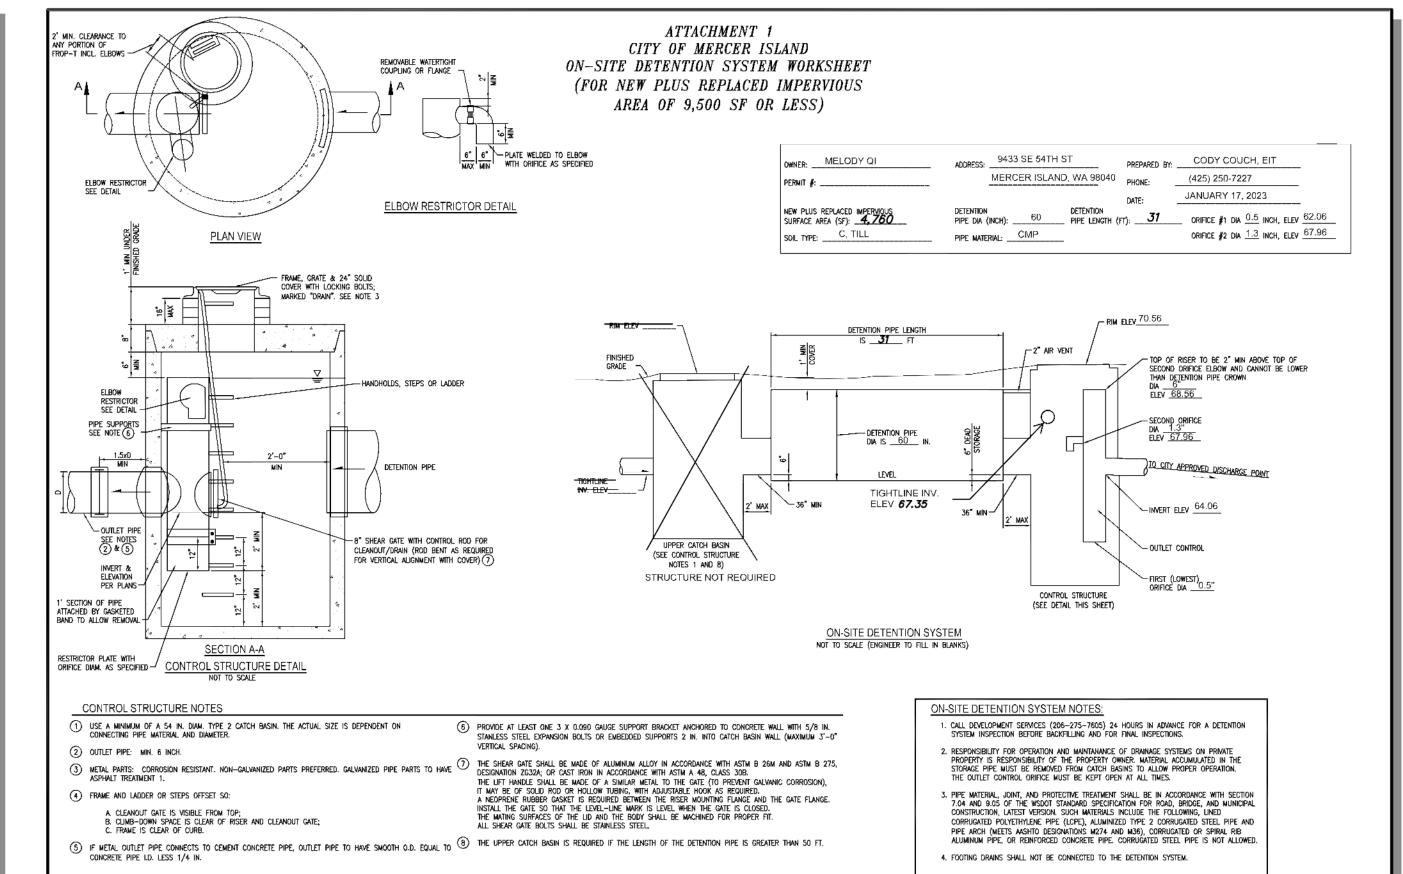



- WATER SERVICES SHALL COMPLY WITH THE REDUCTION OF LEAD IN DRINKING WATER ACT DATED 01/04/2014.
 ON EXISTING WATER MAINS USE NYLON COATED D.I. SADDLE WITH STAINLESS STEEL DOUBLE STRAPS, ROMAC 202NS, OR APPROVED EQUAL.
- 3. MINIMUM DISTANCE BETWEEN CORP STOPS SHALL BE 18". MINIMUM DISTANCE BETWEEN TAPS, BETWEEN CORP STOP AND PIPE ENDS SHALL BE 24", ALL HORIZONALLY STAGGERED.
- 4. PLASTIC METER BOXES SHALL NOT BE INSTALLED WITHIN ROADWAY, SIDEWALK, OR DRIVEWAYS.
- 5. UPON CITY ENGINEER'S APPROVAL, METER BOXES ARE ALLOWED TO BE INSTALLED IN PORTLAND CEMENT CONCRETE PAVEMENT OR SIDEWALK.
- 6. WHEN CONNECTING TO EXISTING PRIVATE SUPPLY LINE CONTAINING FERROUS METAL, PROVIDE INSULATING COUPLING (DB SERIES WITH C21 SERIES ADAPTERS) AND PROVIDE REDUCER AS NECESSARY TO MATCH EXISTING PRIVATE SUPPLY LINE DIAMETER.
- 7. SERVICE LINE SHALL BE PERPENDICULAR TO THE WATER MAIN AND STRAIGHT TO WATER METER, UNLESS OTHERWISE APPROVED BY CITY ENGINEER. PROVIDE WINDING SLACK IN THE SERVICE LINE BETWEEN THE MAIN AND WATER METER.
- 8. WATER METER SUPPLIED BY CITY.

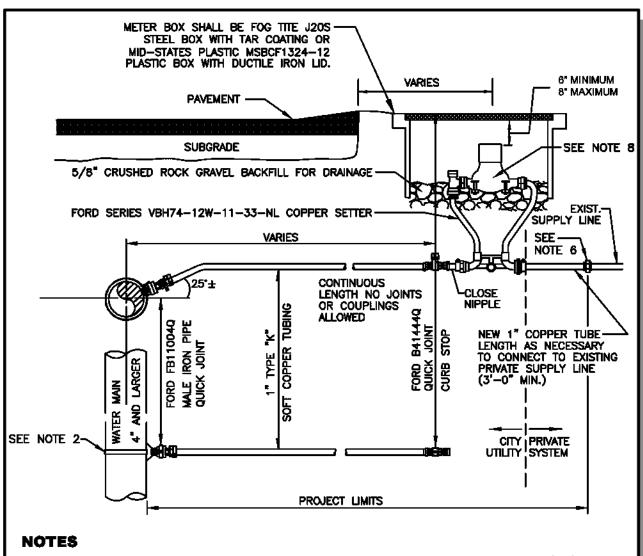
 9. ALL FITTINGS TO BE BRASS COMPRESS
- 9. ALL FITTINGS TO BE BRASS COMPRESSION TYPI FORD QUICK JOINT OR EQUAL.
- NO SERVICE CONNECTIONS BETWEE AND END OF MAIN.

REV DATE

EEER.		CI	CITY OF MERCER ISLAND STANDARD DETAILS WATER				
PE, Off	1" WATER METER INSTALLATION						
	02-05-2021		NO SCALE		CALE	W-13	
						APPROVED	



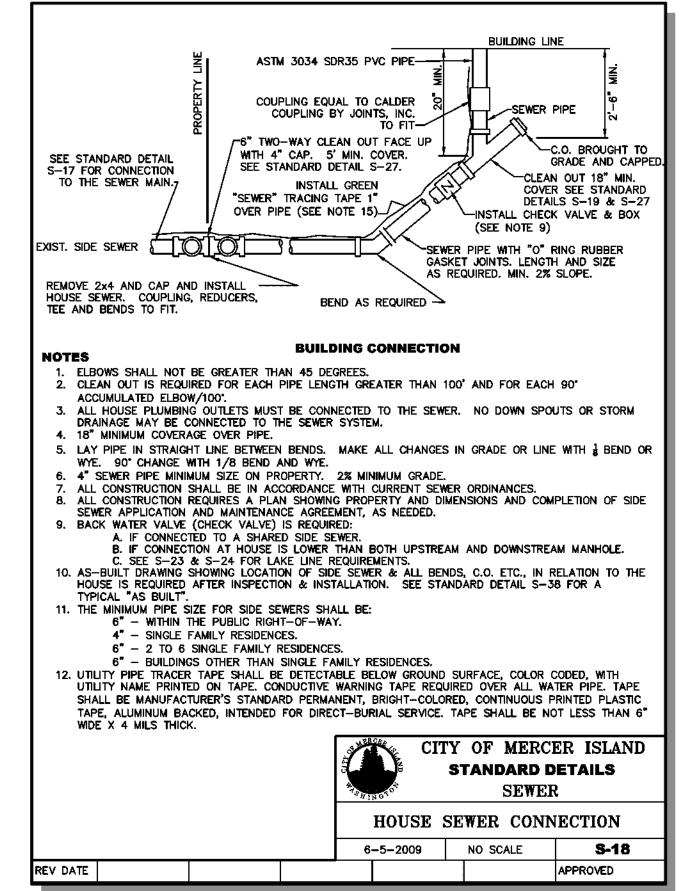

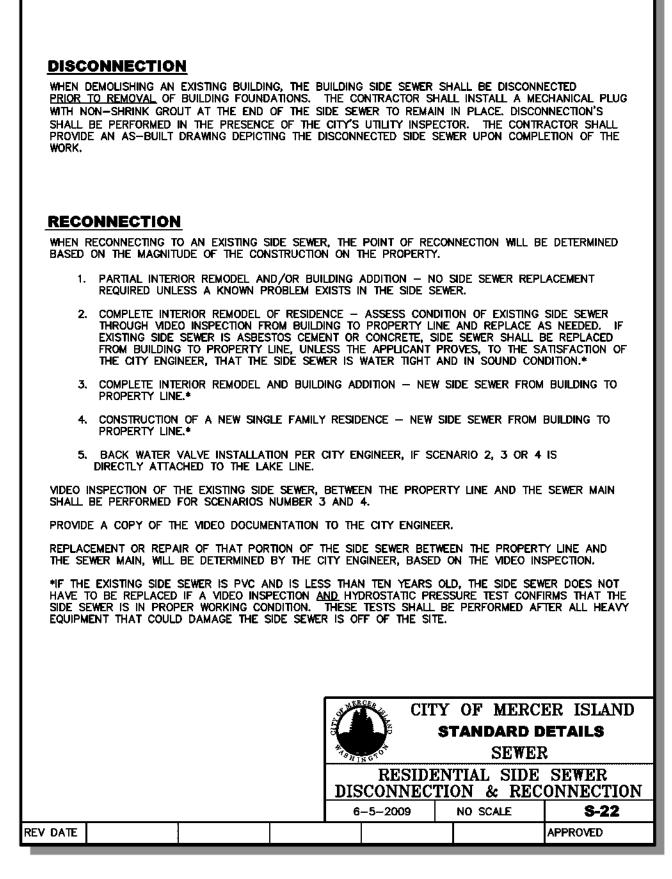

ATWELL 25 CENTRAL WAY, SUITE 400

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SCALE:
AS NOTED
PROJECT MANAGER.

TODD A OBERG, PE
PROJECT ENGINEER:

YANNICK METS, PE DESIGNER: JULIAN ADLER

ISSUE DATE: 7/20/2023

D DATE BY REVISIONS

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